

\L0.0

30% DESIGN DEVELOPMENT NOT FOR CONSTRUCTION

AC	ASPHALT CONCRETE
A.D	AREA DRAIN
AGG	AGGREGATE
AGODA	ACCESSIBLE GUIDELINES FOR OUTDOOD DEVELOPED AREAS, MOST RECENT ED
<b>A</b> L	ALUMINUM
B.C	BOTTOM OF CURB
B.O	вотом об
BS	BOTTOM OF STEP
B.W	BOTTOM OF WALL (FINISH GRADE)
CONC	CONCRETE
C.I.P.	CAST-IN-PLACE
CJ	COLD JOINT
CL	CENTERLINE CORRUGATED STEEL PIPE
CSP CTP	CORRUGATED STEEL PIPE
CTR	CENTER CUBIC VARIOS
C.Y	CUBIC YARDS
D.I /=\	DROP INLET
(E)	EXISTING  EXPANSION JOINT
EJ E O	EXPANSION JOINT
F.O = = =	FACE OF
F.F.E FS	FINISH FLOOR ELEVATION
FS F.G	FINISH SURFACE FINISH GRADE
r.G F.L	
	FLOW LINE
FTG	
	HOT DIP GALVANIZED
GB HP	GRADE BREAK HIGH POINT
нР L.D	LANDSCAPE DRAIN
	LIMIT OF GRADING
L.O.W LP	LIMIT OF WORK LOW POIINT
	MAXIMUM
	MINIMUM
	MARIN MUNICIPAL WATER DISTRICT
(N)	NEW
(N) N.I.C	
N.I.C N/A	
NOM	
O.C. (P)	ON CENTER PROPOSED
(' <i>)</i> P.A	PLANTED AREA
	PRESSURE TREATED DOUGLAS FIR
	REQUIRED
	REDWOOD
SIM	SIMILAR
SJ S.S	SCORE JOINT STAINLESS STEEL
	SEE ARCHITECTURAL DRAWINGS
	SEE CIVIL DRAWINGS
	SEE STRUCTURAL DRAWINGS
г.С	TOP OF CURB
T.S	TOP OF STEP
T.W	TOP OF WALL
т.О	TOP OF
1.0. TYP. –	TYPICAL
гтг Г.W	TOP OF WALL
	UNLESS OTHERWISE NOTED
	VERIFY IN FIELD
	EXTRA-STRONG PIPE

XS	EXTRA-STRONG PIPE	
INDEX SUB SHEET	TITLE OF SHEET	DATE: 6/6/16 SCALE
L0.0	COVER / CONTEXT PLAN	AS SHOWN
L1.0	SITE PLAN	DESIGNED BY  GAR
A1.0	FLOOR PLAN & ROOF PLAN	DRAWN BY
A2.0	ELEVATIONS	GR/LR
L1.1	LAYOUT & GRADING PLAN	CHECKED BY
L1.2	PROPOSED ACCESSIBILITY ANALYSIS	GAR

L4.0 PAVING & FURNISHING DETAILS

L0.0

Roth LaMotte Landscape

ABIN

. WATER DISTRICT RIN COUNTY, CA


MARIN MUNICIP

NO. DATE ISSUE NOTES

NO. DATE REV. NOTES

**PHOENIX** 

IEET & PLAN

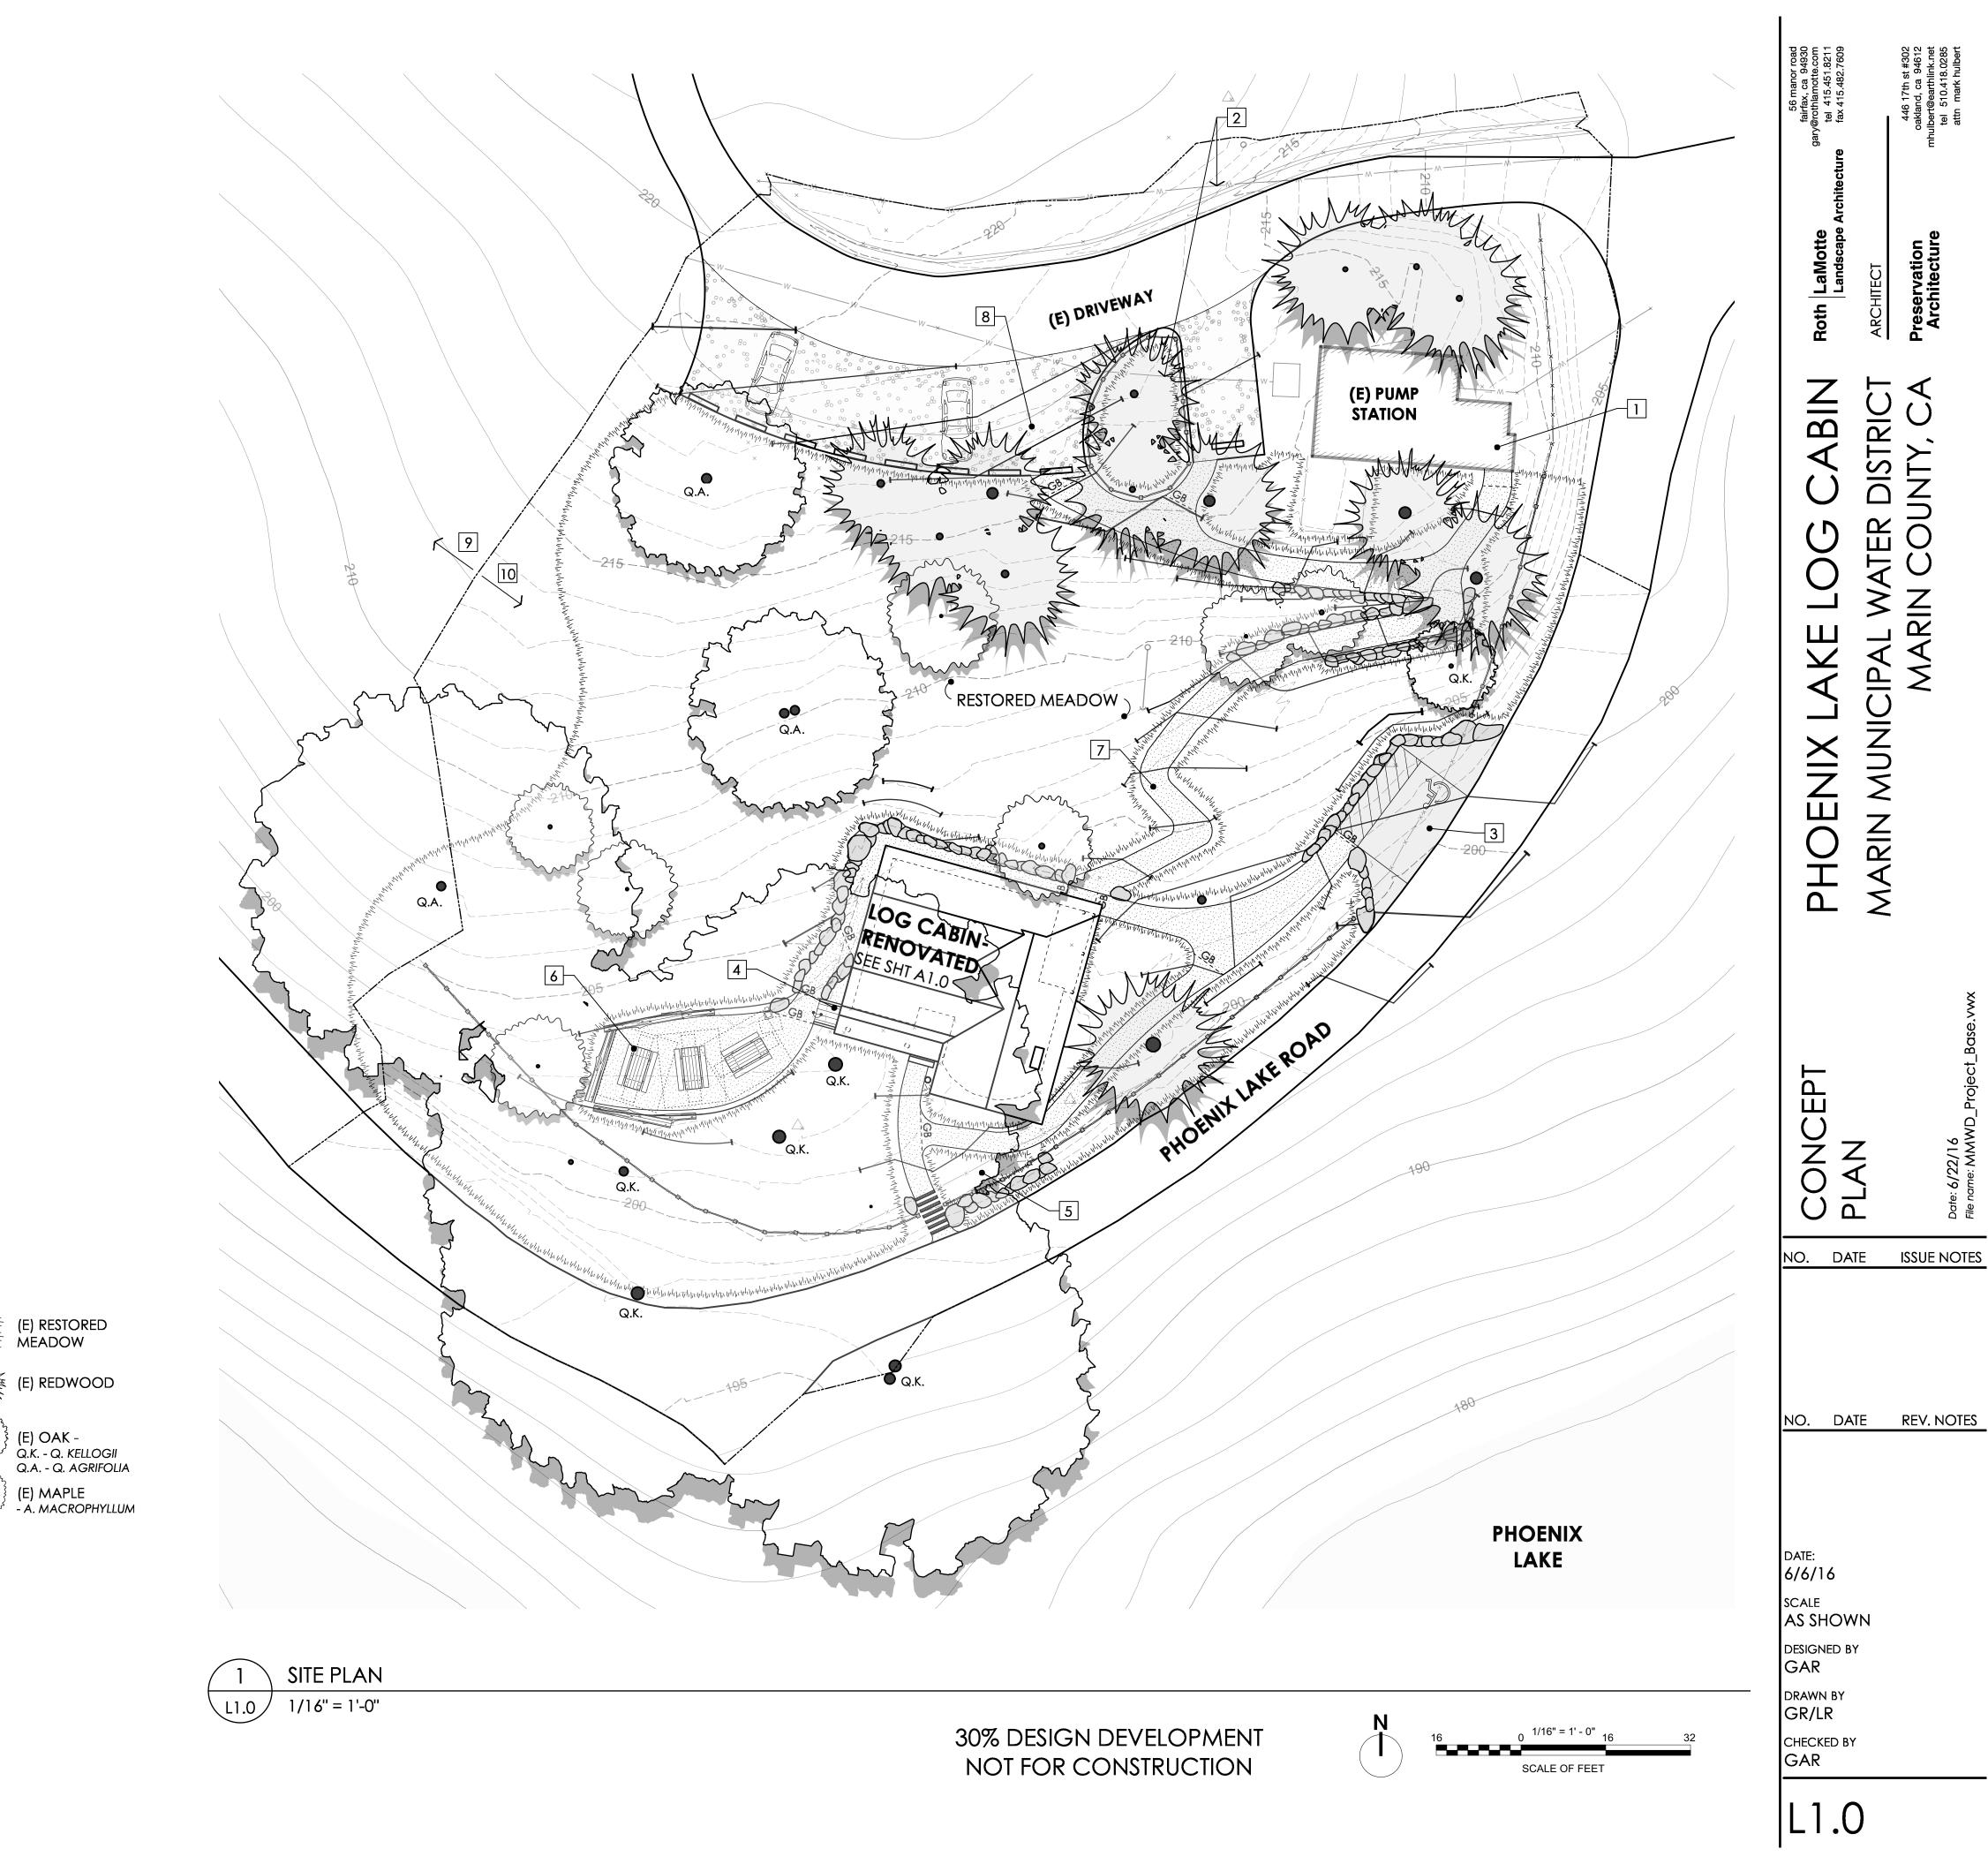

**DRAWING NOTES** 

2. (E) WATER LINE

LEGEND:

1. (E) RESTROOM - RESTORED

3. (N) ACCESSIBLE PARKING

(N) FENCE  $\frac{3}{14.0}$ 

×—×—×- (E) FENCE TO REMAIN

(N) STONE WALL  $\frac{4}{14.0}$ 

(P) CONTOUR - MAJOR

(P) CONTOUR - MINOR

----- EXTENT OF SURVEY

----- (P) GRADE BREAK

 $\times$ –203.5' (P) SPOT ELEVATION

 $\times$  (E) 197' (E) SPOT ELEVATION

\_\_<u>5%</u> (P) SLOPE

 $\widehat{\phantom{a}}$ 

FLUSH

(E) TREE

DECK EXTENSION - OPEN BELOW (PUNCHEON STYLE)

5. (N) BIORETENTION AREA - 70 S.F. MIN.

6. (N) PICNIC AREA

8. RESURFACE (E) PARKING

7. (N) TRAIL 3' - 4'W - V.I.F., BUILT PER MMWD TRAIL STNDS.

9. SURVEY GENERATED FROM MARIN MAP G.I.S. DATA

10. SURVEY RECEIVED FROM MMWD

(N) COMPACTED 2 GRAVEL AGGREGATE 14.0

(N) TIMBER STEP
- PER MMWD STANDARDS

(N) WHEEL STOP
- PER MMWD STANDARDS

(N) PICNIC TABLE

ADA CLEAR SPACE

(N) PLACEMENT 6 LOG/BOULDER 4.0

(N) WATER FOUNTAIN - PER MMWD STANDARDS

(N) CONCRETE PAVING  $\frac{5}{14.0}$ 

/ATER

MARIN MUNICIP

ARIN

NEW WOOD FLOOR CONSTRUCTION **NEW WOOD DECKING** 

NEW WOOD SHAKE ROOFING

(E) EXISTING

(N) NEW

A. THE PROPOSED PROJECT WILL FULLY REHABILITATE THE CABIN INCLUDING SUBSTANTIAL REPAIR, INCLUDNG SELECTIVE REMOVAL AND REPLACEMENT OF DETERIORATED LOGS, WHICH MAY NECESSITATE THE SHORING UP OF THE BUILDING AND SELECTIVE DISASSEMBLY OF THE LOG WALLS.

B. THE WORK WILL INCLUDE RECONSTRUCTION OF THE FRONT PORCH AND ITS CUPOLA TO MATCH THE EXISTING, AS WELL AS PARTIAL RECONSTRUCTION OF THE REAR PORCH. GIVEN THE EXTANT STRUCTURAL AND MATERIAL CONDITIONS OF THE FRONT PORCH AND CUPOLA, ALONG WITH THE FACT THE EXISTING CONSTRUCTION IS NON-HISTORIC, ALTERNATIVE MATERIAL AND STRUCTURAL ASSEMBLIES MAY BE CONSIDERED TO ENSURE GREATER LONGEVITY THAN WOULD RESULT FROM THE USE OF UNPEELED REDWOOD LOG CONSTRUCTION.

C. DOORS AND WINDOWS WILL BE RESTORED AND SELECTIVELY REPLACED.

D. THE ROOFING WILL ALSO BE REPLACED WITH NEW TO MATCH THE EXISTING

E. AT THE INTERIOR, THE SPACES WILL BE REHABILITATED FOR REUSE, INCLUDING THE ADDITION OF BATHROOMS AND OTHER ACCESSIBLE FEATURES, PLUS BUILDING SYSTEM IMPROVEMENTS.

FULL REHABILITATION WORK SHALL INCLUDE:

UNDERTAKE STRUCTURAL PEST INSPECTION AND TREATMENTS.

#### @ EXTERIOR

- 1. RETAIN AND REPAIR EXISTING FOUNDATIONS, INCLUDING REPLACEMENT OF MISSING AND DAMAGED FACE BRICKS, VENTILATION AND FLASHING ASSEMBLIES.
- 2. REPAIR AND SELECTIVELY REMOVE AND REPLACE STRUCTURALLY DAMAGED LOGS: THIS WORK REQUIRES REPLACEMENT OF LOGS AT THE BOTTOM OF WALLS.
- THE PRESUMED LOG RESTORATION METHODOLOGY IS TO SHORE AND LIFT THE UPPER STRUCTURE AND ROOF IN ORDER TO DISASSEMBLE AND RECONSTRUCT LOG WALLS.
- EXISTING LOGS AT WALLS WITH CONCEALED FINISHES AT INTERIORS REQUIRE INSPECTION AND EVALUATION AT THE INTERIOR FACE.
- SOME LOG WORK AT THE FRONT BAY, FOR EXAMPLE ARE SPLIT RATHER THAN FULL LOGS. DETERMINE FEASIBILITY OF RETAINING SPLIT LOGS OR, ALTERNATIVELY, REPLACING SPLIT LOGS AT WALLS WITH FULL LOGS.

### @ EXTERIOR - CONT.

- REMOVE AND REPLACE FRONT PORCH TO MATCH EXISTING, EXCEPT ALTER SPACING OF THE CENTRAL PORCH POST AS PART OF THE RECONSTRUCTION OF
- 4. REMOVE AND RECONSTRUCT FRONT PORCH ROOFS AND CUPOLA. WHILE THE INTENT IS TO REPLACE THE EXISTING CUPOLA TO VISUALLY MATCH THE EXISTING UNPEELED LOG CONSTRUCTION, ALTERNATIVELY, UNPEELED LOGS MAY BE SUBSTITUTED, AND THE NEW SUPPORT STRUCTURE MAY REQUIRE ADDITIONAL WOOD OR METAL FRAMING TO BE CONCEALED ALONG WITH POSSIBLE NEW FOUNDATION WORK.
- REMOVE ORNAMENTAL LOG WORK AT FRONT OF LIVING ROOM WING.
- RETAIN AND STRENGTHEN EXISTING FRONT CHIMNEY, REMOVING THE CHIMNEY
- CAP AND SEALING THE CHIMNEY FROM FUTURE USE. 7. REMOVE EXISTING REAR CHIMNEY AND REPAIR OR REPLACE UNDERLYING LOGS.
- 8. REPAIR AND REBUILD EXISTING REAR PORCH WITH NEW LOG POST AND RAIL WORK AND NEW DECKING. WHILE THE INTENT IS TO REPLACE TO MATCH THE EXISTING UNPEELED LOG CONSTRUCTION, ALTERNATIVELY, UNPEELED LOGS MAY BE SUBSTITUTED.
- RESTORE AND REPAINT WOOD WINDOW SASHES AND SILLS, OR SELECTIVELY REPLACE TO MATCH; REPLACE SPLIT LOG WINDOW SILLS WHERE DAMAGED OR
- 10. REPLACE WOOD SHINGLE ROOFING AND ROOF DRAINAGE (FLASHING) ASSEMBLIES TO MATCH EXISTING. ADD GUTTERS AND DOWNSPOUTS AS
- 11. PROVIDE NEW EXTERIOR LED LIGHTING AT FRONT AND REAR PORCHES.

### @ INTERIOR - GENERAL

- 12. SELECTIVELY REMOVE INTERIOR WOOD FRAME PARTITIONS, DOORS AND INTERIOR WALL FINISHES.
- 13. REPAIR UNDERLYING LOG WORK WHERE NEWLY EXPOSED.
- 14. RETAIN INTERIOR LOG WALLS AND CEILINGS.
- 15. REPAIR DAMAGED LOG AND WOOD CEILINGS.
- 16. ADDRESS RODENT/PEST DAMAGE AND CONTROL. PROVIDE ACCESS TO ATTIC
- 17. BUILD NEW, ACCESSIBLE RESTROOM (AT EXISTING BATHROOM), PLUS AN OPTIONAL SECOND TOILET ROOM (AT EXISTING CLOSET).
- 18. REPAIR AND REFINISH WOOD FLOORS.
- 19. CONSTRUCT NEW FLOOR LEVEL IN WEST HALF OF LIVING ROOM.
- 20. UPGRADE AND/OR REPLACE PLUMBING AND ELECTRICAL SYSTEMS.
- 21. ADD INTERNET/WIFI.

#### @ INTERIOR - ROOM-BY-ROOM

#### KITCHEN:

- 22. REMOVE ALL EQUIPMENT AND FIXTURES EXCEPT FOR SINK, TO BE REMOVED AND REINSTALLED, AND BUILT-IN PANTRY CABINET, TO BE RETAINED AND RESTORED.
- 23. REMOVE WOOD WAINSCOTING FROM WEST EXTERIOR WALL; RETAIN, REPAIR AND REFINISH AT NORTH EXTERIOR WALL AND AT EAST AND SOUTH INTERIOR WALLS.
- 24. CLEAN AND REPAIR EXPOSED INTERIOR LOGWORK AT WALLS AND CEILINGS.
- 25. INSTALL NEW WOOD ACCESS DOOR AT ATTIC ACCESS AT UPPER EAST WALL.
- 26. RETAIN AND RESTORE DOORS. 27. REPLACE CENTRAL LIGHT FIXTURE WITH NEW LED PENDANT AND REPLACE EXISTING WALL MOUNTED LIGHT AT SINK WITH NEW LED WALL-MOUNTED FIXTURE.


@ INTERIOR - ROOM-BY-ROOM - CONT.


- 28. RETAIN AND CLEAN MASONRY FIREPLACE AND HEARTH; ADD NEW FIXED GRILLE OR DOORS AT FIREPLACE OPENING TO PROHIBIT USE.
- 29. REMOVE WOOD PANELING AT EXTERIOR LOG WALLS, IF FEASIBLE (INSPECTION AND EVALUATION IS REQUIRED TO DETERMINE FEASIBILITY). IF FEASIBLE, RETAIN EXPOSED LOGS AT INTERIOR. WHERE SPLIT LOGS OCCUR (EX: AT FRONT BAY), ALTERNATIVELY REPLACE WITH FULL LOG ASSEMBLIES.
- 30. RETRIM EXISTING WINDOW OPENINGS WITH EXISTING OR MATCHING WOOD TRIM. 31. REMOVE WOOD PARTITION AND DOOR BETWEEN LIVING AND ENTRY, REPAIR
- FLOORS, WALLS AND CEILINGS AT AREA OF REMOVAL. 32. ADD NEW WOOD FRAME AND WOOD FINISHED FLOOR AND STEP ATOP REAR
- PORTION OF EXISTING FLOOR. 33. RETAIN, REFURBISH AND RELAMP EXISTING PENDANT LIGHT FIXTURE.

### DINING:

- 34. REMOVE WOOD PANELING AT EXTERIOR LOG WALLS, IF FEASIBLE (INSPECTION AND EVALUATION IS REQUIRED TO DETERMINE FEASIBILITY). IF FEASIBLE, RETAIN EXPOSED LOGS AT INTERIOR. WHERE SPLIT LOGS OCCUR, ALTERNATIVELY REPLACE WITH FULL LOG ASSEMBLIES.
- 35. RETRIM EXISTING WINDOW OPENINGS WITH EXISTING OR MATCHING WOOD TRIM.
- 36. REMOVE WOOD PARTITION AND DOOR BETWEEN DINING AND ENTRY, REPAIR FLOORS, WALLS AND CEILINGS AT AREA OF REMOVAL.
- 37. CLEAN AND REPAIR EXPOSED INTERIOR LOGWORK AT WALLS AND CEILINGS.
- 38. RETAIN, REFURBISH AND RELAMP EXISTING PENDANT LIGHT FIXTURE.

- 39. REMOVE ALL EXISTING EQUIPMENT AND FIXTURES, INSTALL ALL NEW PLUMBING, ELECTRICAL AND LIGHTING EQUIPMENT AND FIXTURES.
- 40. REMOVE WOOD PANELING FROM WEST EXTERIOR WALL; RETAIN, REPAIR AND REFINISH PANELING AT NORTH, EAST AND SOUTH INTERIOR WALLS.
- 41. REMOVE EXISTING DOOR AND REPLACE WITH NEW 3 FOOT WIDE WOOD DOOR AND OPENING TO MATCH EXISTING.

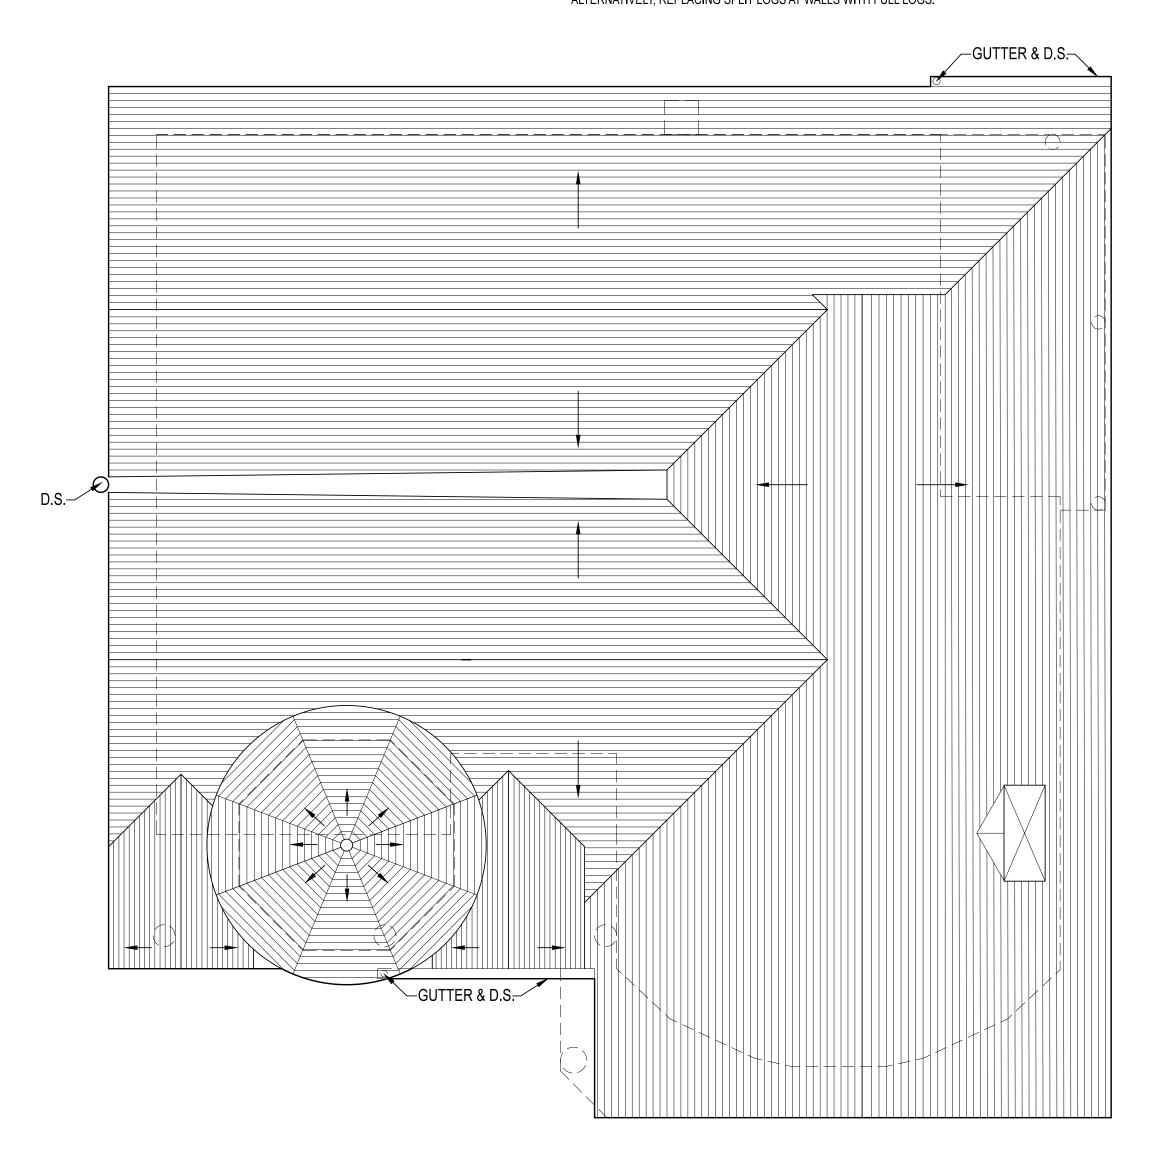

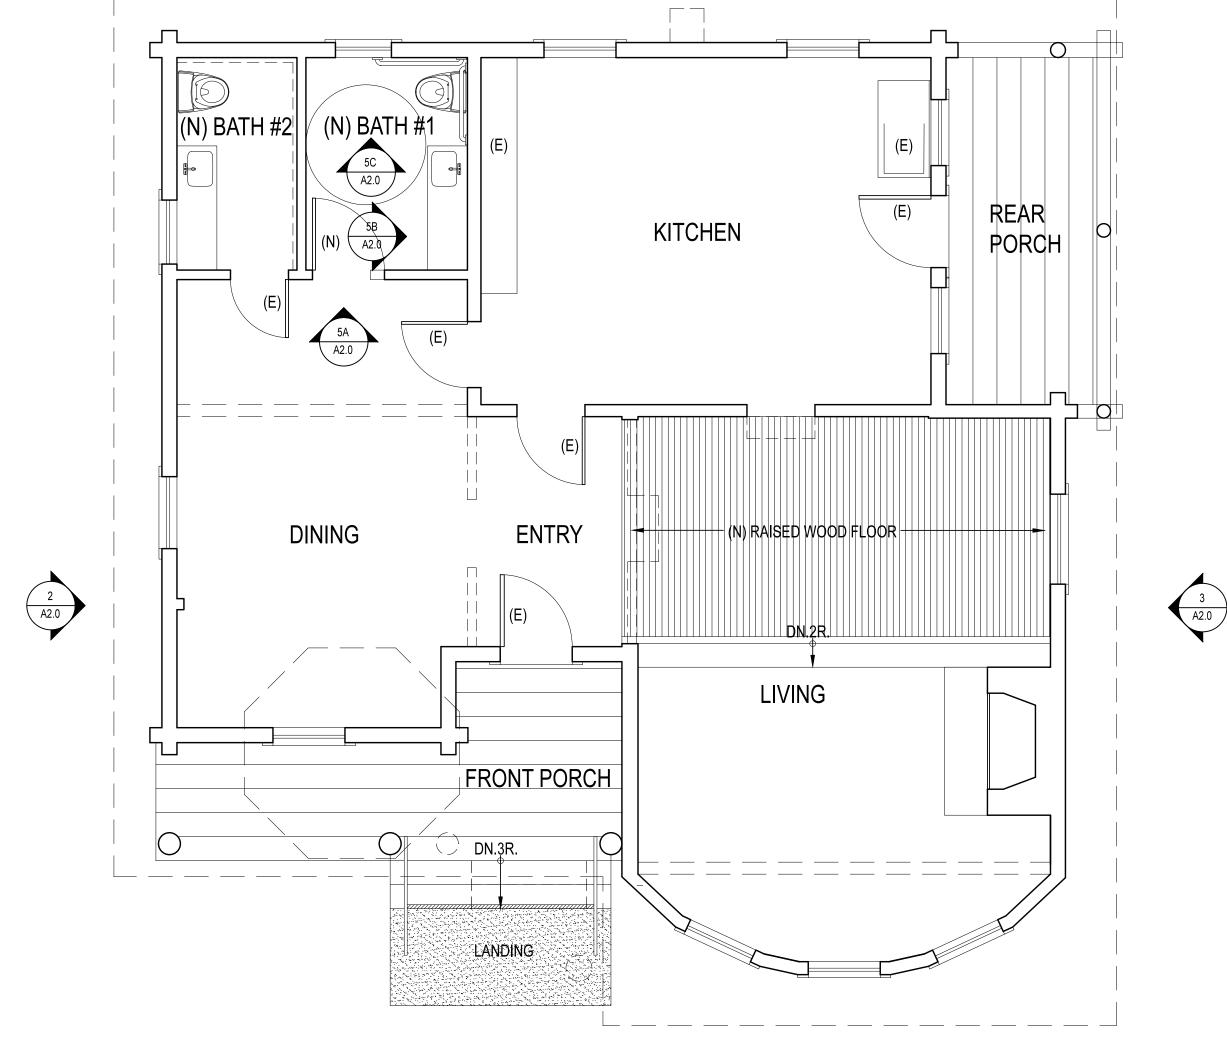



FLOOR PLAN 1/4" = 1'-0" (22x34 sheet) 1/8" = 1'-0" (11x17 sheet)



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**ISSUE NOTES** 

DATE REV. NOTES

:rNo :rDate :rNote


:iNo :iDate :iNote

DATE: 5/26/16 SCALE AS SHOWN DESIGNED BY MH

DRAWN BY MH

CHECKED BY

A1.0

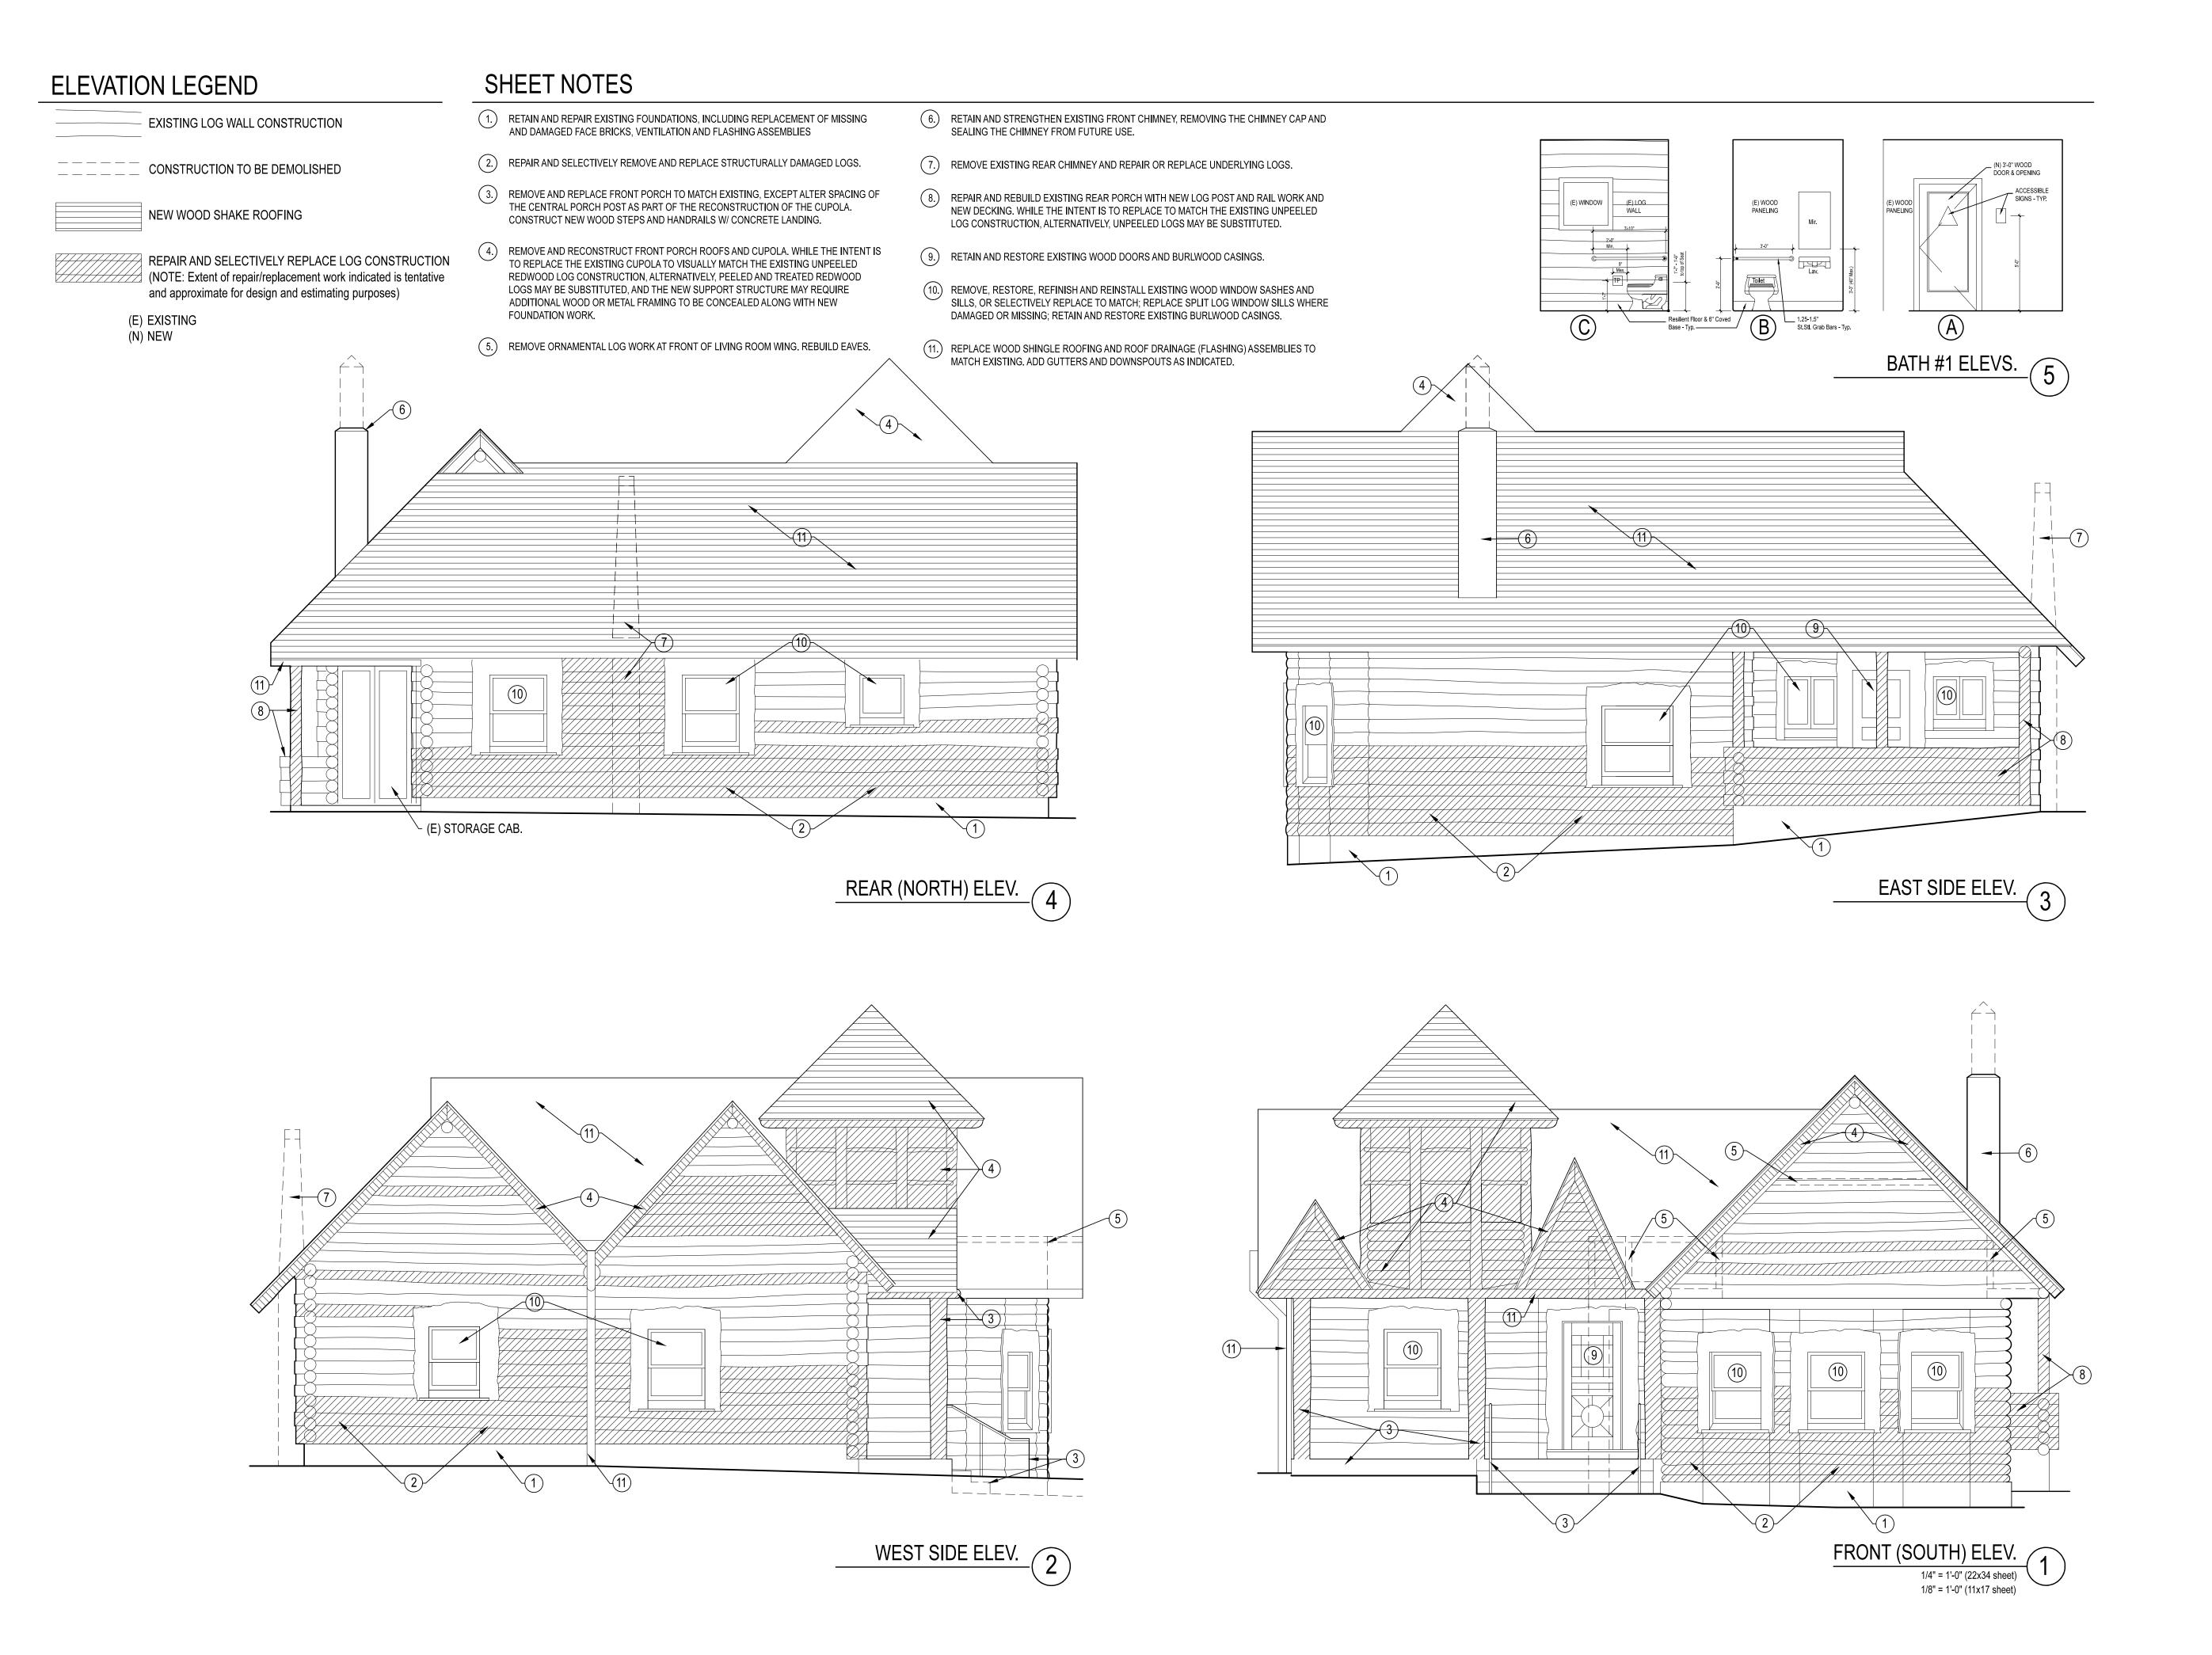

ABIN MUNIC PHOENIX MARIN

ISSUE NOTES :iNo :iDate :iNote

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ELEVATION

NO. DATE REV. NOTES

6/1/16 scale AS SHOWN


MH DRAWN BY MH


DESIGNED BY

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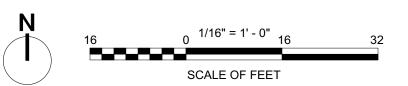
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:rNo :rDate :rNote



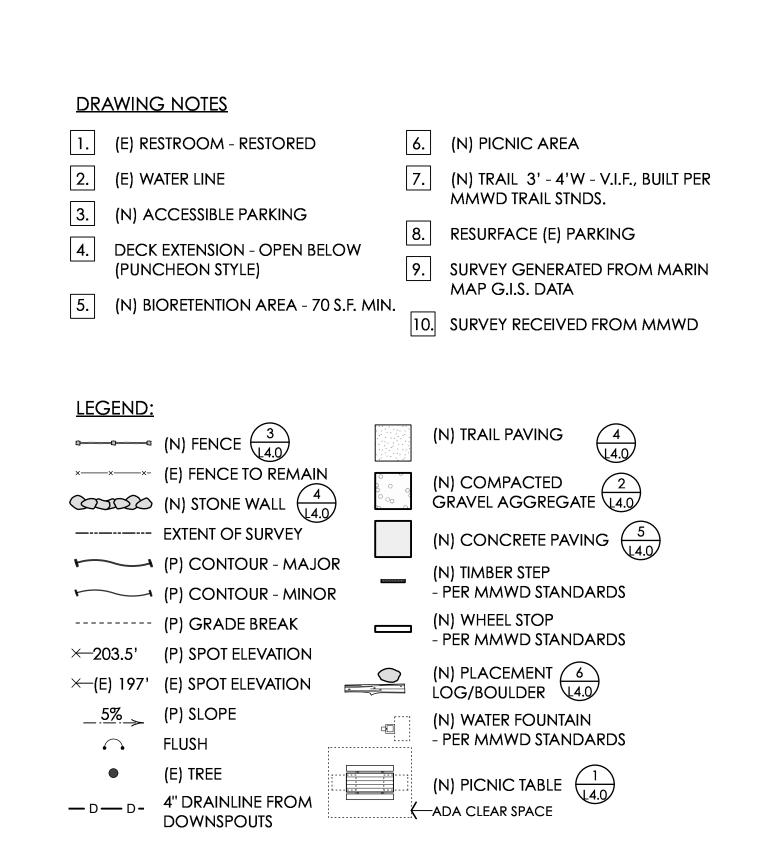

NOT FOR CONSTRUCTION

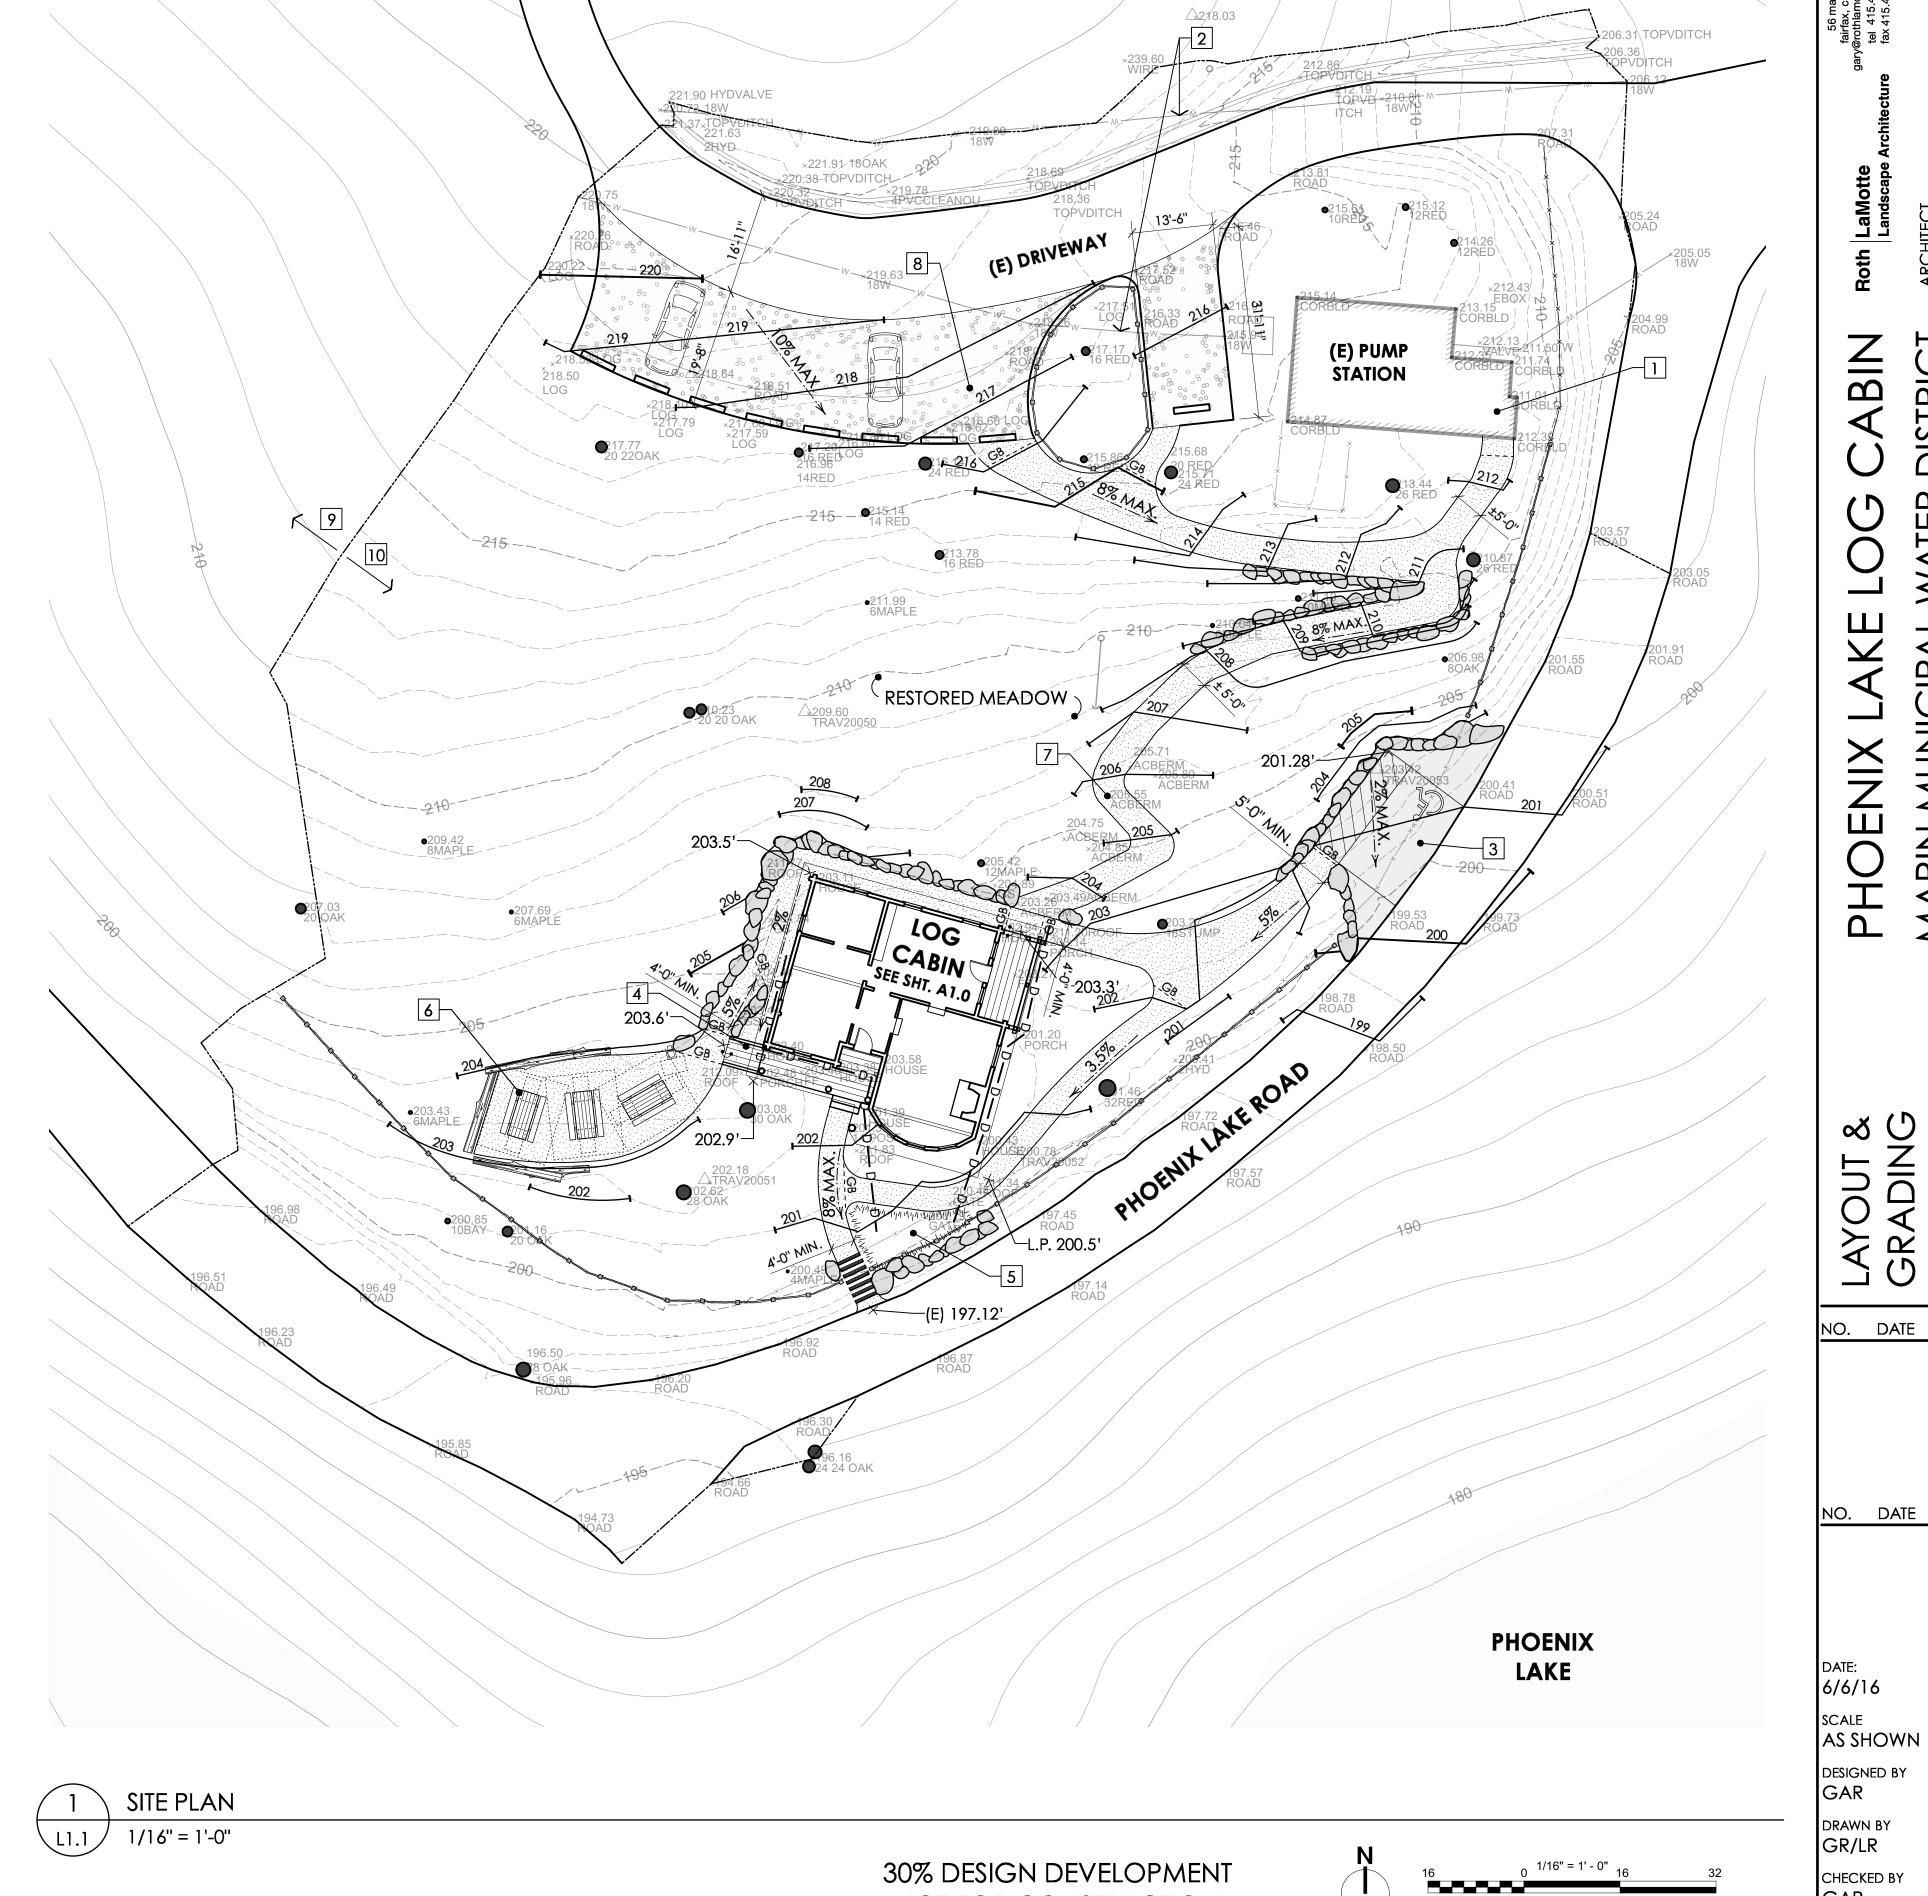

DESIGNED BY GAR DRAWN BY GR/LR CHECKED BY GAR

DATE: 6/6/16

Roth LaMotte Landscape

ABIN

DISTRICT JNTY, CA

WATER

MARIN MUNICIP

**PHOENIX** 

OUT & ADING

NO. DATE ISSUE NOTES

NO. DATE REV. NOTES

ARIN

# PHOENIX LAKE LOG CABIN - PROPOSED SCHEME SUMMARY OF PATH OF TRAVEL SEGMENTS

		I	<u> </u>	T
SEGMENT	ACCESS STANDARD	RUNNING SLOPE	CROSS SLOPE	SURFACE TYPE
A - B	CBC	8% max.	2% max.	Concrete
B - C	CBC	<5%	2% max.	Resin Modified Compacted Aggregate
C - D	CBC	<5%	2% max.	Resin Modified Compacted Aggregate
D - E	CBC	1% - 2%	2% max.	Resin Modified Compacted Aggregate
E - F	CBC	<5%	2% max.	Resin Modified Compacted Aggregate
F - G	CBC	0%	2% max.	Wood Deck
<b>K</b> *	CBC	2% max.	2% max.	Resin Modified Compacted Aggregate
D - J	CBC	0%	2% max.	Wood Deck
C - I	CBC	<5%	2% max.	Resin Modified Compacted Aggregate
I - H	CBC	3.5%	2% max.	Resin Modified Compacted Aggregate
1 - 2	NA	8% max.	3% - 5%	Resin Modified Compacted Aggregate
2 - 3	NA	8% max.	3% - 5%	Resin Modified Compacted Aggregate
3 - D	NA	8% max.	3% - 5%	Resin Modified Compacted Aggregate
2 - 5	NA	5.1%	3% - 5%	Resin Modified Compacted Aggregate
3 - 4	NA	8% max.	3% - 5%	Resin Modified Compacted Aggregate
6 - 7	NA	8% max.	2% max.	Resin Modified Compacted Aggregate

## **LEGEND**

NA Not Accessible to CBC ADA Standards CBC 2010 California Building Code Chapter 11B Accessibility Standards

> [1] Trail accessibility designation is preliminary and is based upon basic slope, surface and width considerations only. The project is still in schematic design and subject to design refinements due to programmatic or technical considerations that may necessitate minor adjustments to the design footprint.

ACCESSIBILITY STANDARD 2010 CALIFORNIA BUILDING CODE CHAPTER 11B ACCESSIBILITY STANDARDS.

**GENERAL NOTES** SLOPES NOTED ARE APPROXIMATE CALCULATIONS BASED UPON THE SURVEY DATA. ACTUAL SLOPES MAY VARY.

# ADA LEGEND


TRAIL SEGMENT -SEE ACCESSIBILITY MATRIX

PROPOSED PICNIC AREA - SEE ACCESSIBILITY MATRIX PROPOSED TRAIL - NOT ACCESSIBLE, SEE MATRIX

PROPOSED TRAIL - PER CBC 2010 ADA STANDARD, SEE MATRIX



30% DESIGN DEVELOPMENT NOT FOR CONSTRUCTION

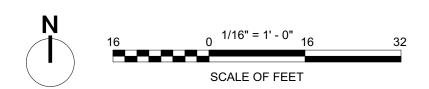

CHECKED BY GAR

ABIN

ATER

MARIN MUNICIP

PROPOSED ACCESSIBILITY ANALYSIS

NO. DATE ISSUE NOTES

NO. DATE REV. NOTES

PHOENIX

6/6/16


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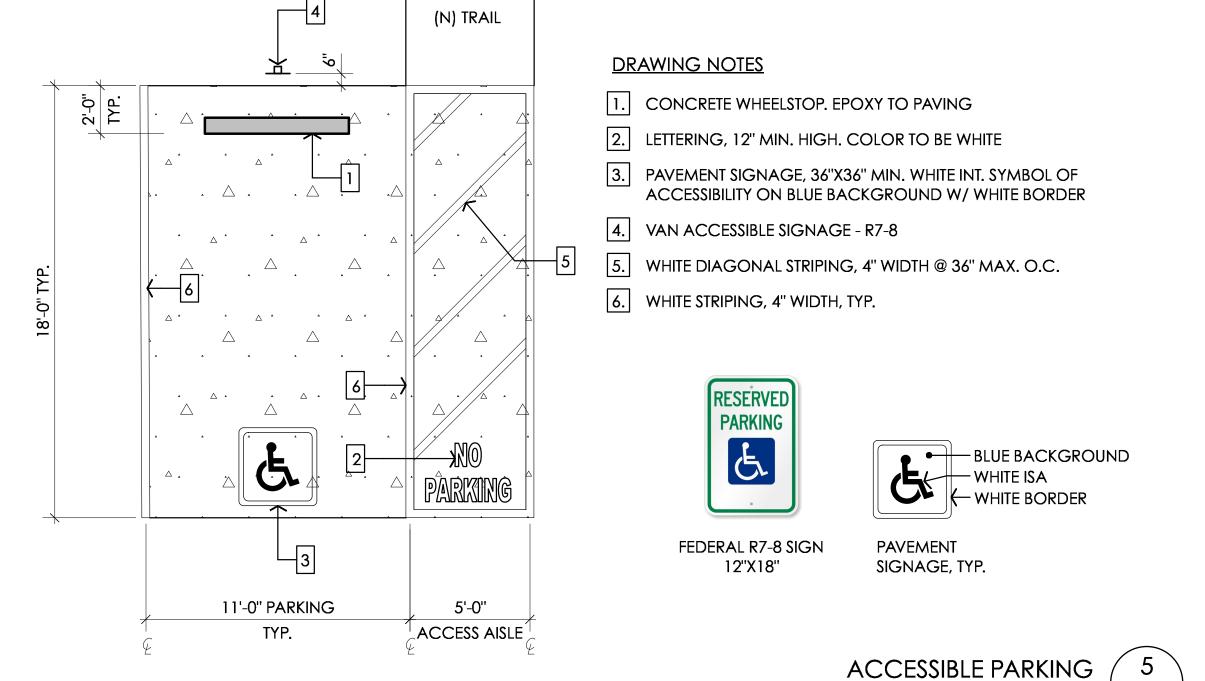
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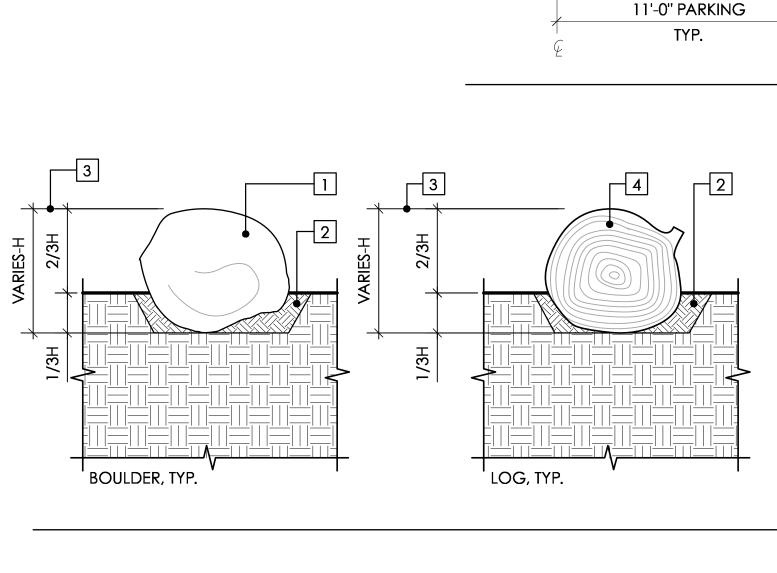
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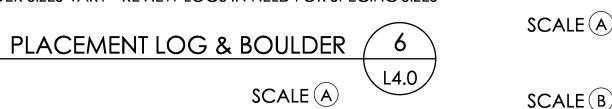




# **DRAWING NOTES**

1. APPROVED STONE


- 2. COMPACTED BACKFILL
- 3. DIM AS REQ'D TO KEEP LOG/BOULDER FROM ROLLING OR SHIFTING.
- **GENERAL NOTES**
- (A) LOGS/BOULDERS TO BE SALVAGED FROM SITE.
- B CONTRACTOR TO PLACE LOG/BOULDER SECURELY AND FIRMLY IN POSITION PER PLANS AND PENDING FIELD VERIFICATION BY MMWD.
- C LOGS TO HAVE SHARP TWIGS AND SPLINTERS REMOVED, BARK MAY REMAIN.
- 4. PLACEMENT LOG ±24" DIA. D LOGS/BOULDERS TO BE SET INTO GRADE AND SURROUNDING GRADE COMPACTED TO PREVENT SETTLEMENT OR SHIFTING OF THE LOG.
  - (E) LOG/BOULDER SIZES VARY REVIEW LOGS IN FIELD FOR SPECIFIC SIZES

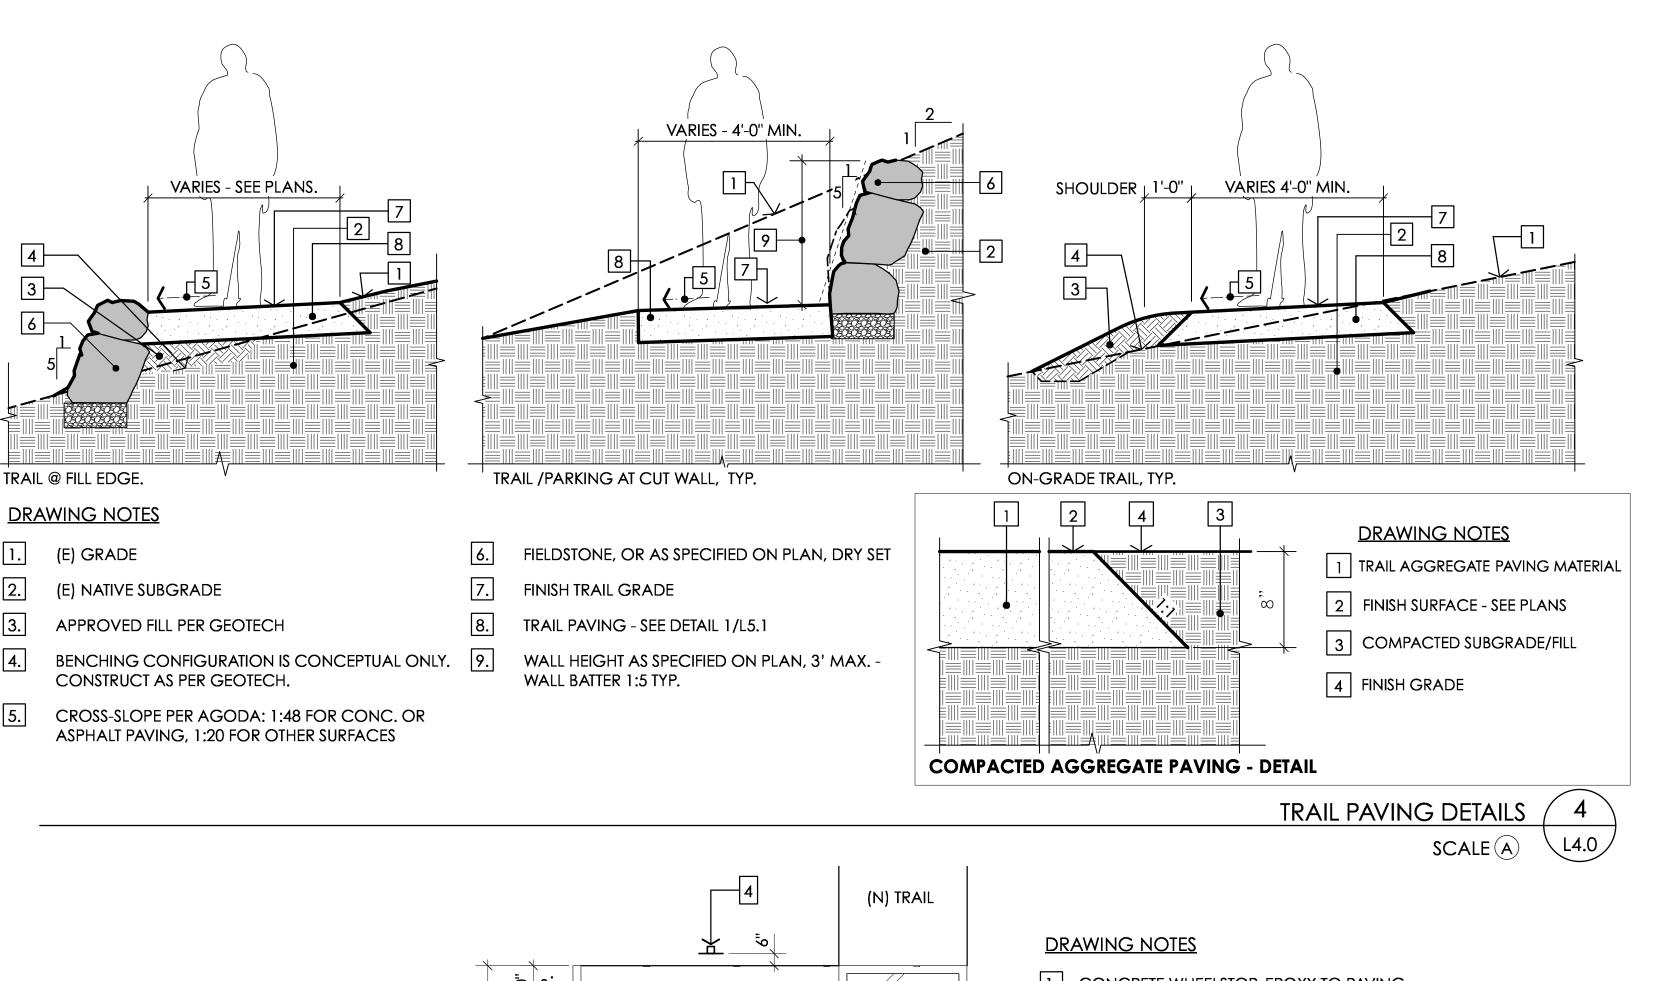

SCALE OF FEET 1-1/2" = 1' - 0"

SCALE OF INCHES

SCALE C

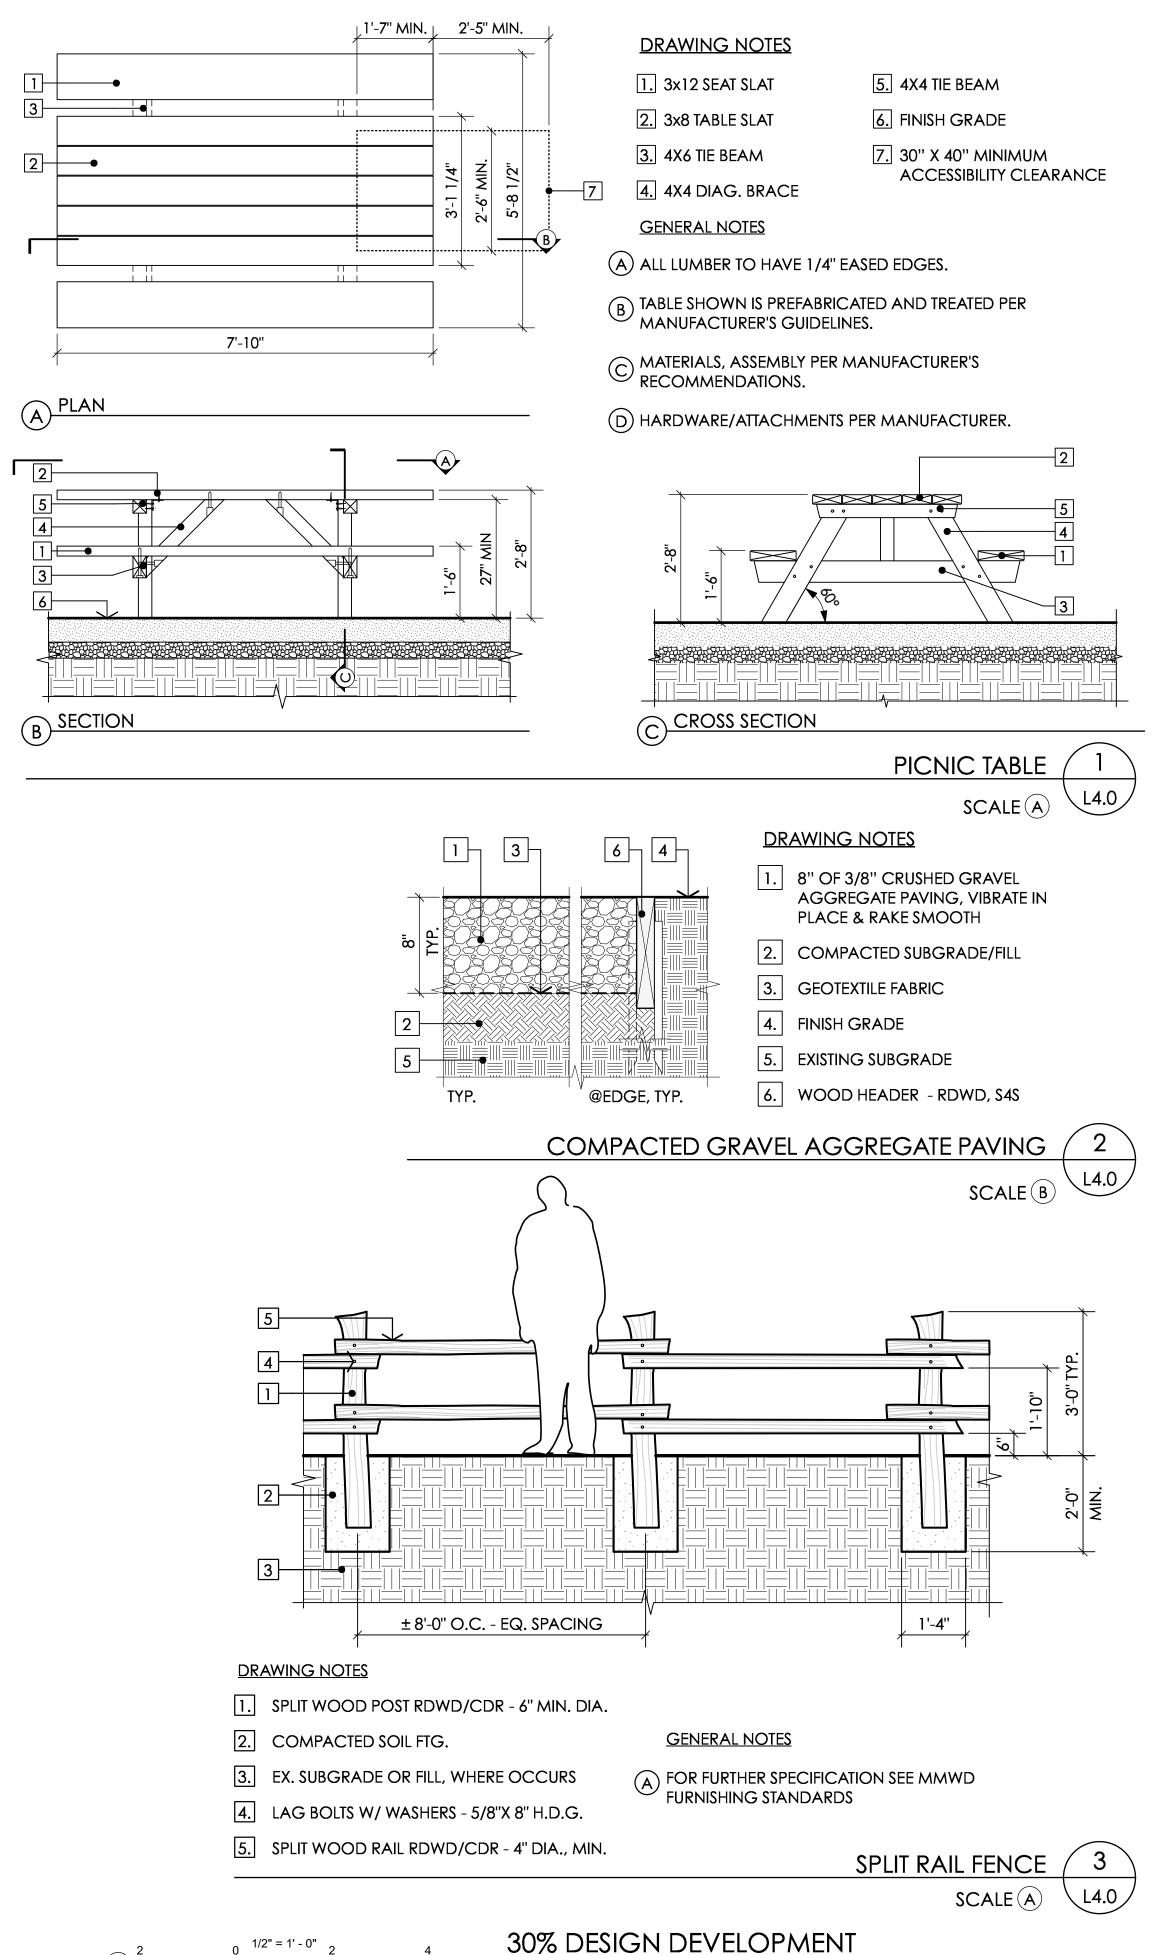

NOT FOR CONSTRUCTION

SCALE OF FEET

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NO. DATE ISSUE NOTES

NO. DATE REV. NOTES

6/6/16 SCALE AS SHOWN

DESIGNED BY GAR DRAWN BY GR/LR

CHECKED BY GAR

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